- 1. PLANS WILL NEED TO BE VERIFIED BY A STRUCTURAL ENGINEER
- 2. A WORK IN THE RIGHT-OF-WAY PERMIT IS REQUIRED. THIS PERMIT TAKES FOUR BUSINESS DAYS TO PROCESS. THERE IS NO FEE FOR THIS PERMIT. PLEASE CONTACT TRAFFIC KNIGNEERING AT 912-551-5600. IT IS THE RESPONSIBILTY OF THE CONTRACTOR TO KEEP THIS PERMIT UP TO DATE. THE CONTRACTOR CANNOT BEGIN WORK UNTIL THEY RECEIVE THIS PERMIT.
- CALL 811 BEFORE YOU DIG. CONTRACTOR IS REQUIRED TO OBTAIN A UTILITY LOCATE (DIG TICKET) BEFORE EXCAVATION AND KEEP THE DIG TICKET UPDATED.
- 4. THE SIGN LOCATION WILL NEED TO BE STAKED BY THE CONTRACTOR AND APPROVED BY TRAFFIC ENGINEERING BEFORE EXCAVATION WORK CAN OCCUR.
- 5. SUBMIT BRICK, MORTAR, AND CAP COLOR TO THE OWNER FOR APPROVAL PRIOR TO ORDERING.
- 6. Submit shop drawing of the sign insert to owner for approval prior to fabrication.
- 7. GRASS AND MULCH ALL DISTURBED AREAS. REMOVE ALL EXCESS SOIL
- 8. ALL CONSTRUCTION SHALL CONFORM TO THE INTERNATIONAL BUILDING CODE CURRENTLY ADOPTED BY THE CITY OF SAVANINAH. REFERENCE TO OTHER SPECHCATIONS OR CODES SHALL MEAN THE LATEST STANDARD OR CODE ADOPTED OR FUBILISHED.
- DRAWING SHOW TYPICAL AND CERTAIN SPECIFIC CONDTIONS ONLY. FOR DETAILS NOT SPECIFICALLY SHOWN PROVIDE DETAILS SIMILAR TO THOSE SHOWN.
- 1. VERIFY ALL EXISTING CONDITIONS, DIMENSIONS, AND ELEVATIONS BEFORE STARTING WORK NOTIFY THE OWNER OF ANY DISCREPANCY. THE CONTRACTOR IS SOLEY RESPONSBILE FOR THE DESIGN, ADEQUACY, AND SAFETY OR ERECTION BRACING, SHORING, TEMPROARY SUPPORTS, ETC. THE STRUCTURAL ELEMENTS ARE NOT TABLE UNTIL THE STRUCTURE IS COMPELTE.
- 12. REVIEW OF SHOP DRAWINGS OR OTHER SUBMITTALS BY THE OWNER DOES NOT RELIEVE THE CONTRACTOR OF RESPIBILISTY TO REVIEW AND CHECK SHOP DRAWINGS SEFORE SUBITTAL TO THE OWNER. THE CONTRACTOR RERMAINS SOLF RESPONSIBLE FOR ERBORS AND OMISSIONS ASSOCIATED WITH THE PREPERATION OF SHOP DRAWINGS AS THEY PERTAIN TO MEMBER SIZES. DETAILS, AND DIMENSION SPECIFIED IN THE CONTRACTOR DOCUMENTS.
- 13. THE CONTRACTOR IS SOLEY RESPONSBILE FOR THE MEANS, METHODS, TECHNIQUES, SEQUENCES AND OPERATIONS OF CONSTRUCTION AND SAFETY PRECAUTIONS PROGRAMS INCOENTAL THEREFO.
- . USE ONLY DIMENSIONS INDICATED ON THE DRAWINGS. DO NOT SCALE DRAWINGS OR USE ANY DIMENSIONS TAKEN FROM ELECTRONIC DRAWING FILES.
- 15. THE CONTRACTORS SHALL FURNISH ALL LABOR, MATERIALS, AND EQUIPMENT FOR SUCCESSFUL COMPLETION OF THE PROJECT.
- THE CONTRACTOR SHALL NOTIFY THE OWNER IMMEDIALTY OF ANY DISCREPANCIES BETWEEN THE FLANS AND ANY OTHER DOCUMENTS OR EXISTING CONDITIONS FOR RESOLUTION PRIOR TO PROCEEDING WITH THE WORK.
- 17. THE SPECIFICATIONS ARE AN INTERGRAL PART OF THE CONTRACT DOCUMENTS AND SHALL BE USED IN CONJUNCTION WITH THE BRAWINGS. IN CASES, IF AWY, WHERE REQUIREMETINS INDICATED ON THE DRAWINGS DIFFER FROM THE SPECIFICATIONS, NOTIFY THE OWNER. FOR PRICING, ASSUME THE MORE STRIGNENT REQUIREMENT.
- 18. THE LOCATION OF ANY UTILITIES ON THE DRAWINGS ARE APPROXAMTE, MAY BE INCOMPLETE, AND THOSE SHOWN ARE NOT NECESSARILY ALL OF THE EXISITING UTILITES AND STRUCTURES, VERIFICATION OF EXCAT LOCATIONS SHOULD BE MADE PRIOR TO ANY
- COMPACTION REQUIREMENTS: COMACTED TO 95% DENSITY IN ACCORDANCE WITH ASTM-d-1557.
- CONCRETE SPECIFICATIONS:
- ALL CONCRETE WORK SHALL CONFORM TO ACI 301. "SPECIFICATION FOR STRUCTURAL CONCRETE FOR BUILDINGS. LATEST EDITION.
- 2. UNLESS OTHERWISE NOTED ALL CONCRETE SHALL BE NORMAL WEIGHT AND HAVE THE FOLLOWING MINIMUM 28 DAY STRENGHTS:
- 4. CONCRETE MIX DESIGNS SHALL BE SUBMITTED TO THE ENGINEER AND THE OWNER'S TESTING LAB FOR APPROVAL

- RESPSONIBLITY FOR OBTAINING THE REQUIRED CONCRETE DESIGN STRENGTH IS THE RESPONIBLITY OF THE CONTRACTOR
- 6. USE OF CALCIUM CHOLORIDE, CHORLIDE IONS, OR OTHER SALTS IN CONCRETE IS NOT PERMITTED. THE USE OF RECYLED CONCRETE IS NOT PERMITTED.
- 7. COLD JOINTS ARE NOT PERMITTED
- S. COAT ALL SLABS WITH CURING COMPOUND WITHIN 24 HOURS OF PLACING, PRODUCT USED SHALL CONFORM WITH ATM GOODS AND SHALL BE COMPAPTIBLE WITH ADHERED FINISHES. A SISSIPATING FORMULATION SHALL BE USED AT CEMENTITOUS FINISHES.
- 9. THE CONTRACTOR SHALL COMPLETE THE FOUNDATION IS ONE POUR, EACH TRUCK WILL BE SAMPLED IN ACCORDANCE WITH ASTM C172, PERFORMTHE FOLLOWING TESTS IN ACCORDANCE WITH THE INDICATED STANDARD:



	И
	a
	"
	=
	J
	0
	_
	4
	C
	C
	G
	2
ຜ	U
Scale:	
ale	
Ф	
_	
Z.	
-	
S	
	1

AWING SHOW I YPICAL AND CERTAIN SPECIFIC CONDITIONS ONLY. FOR DETAILS NOT ECIFICALLY SHOWN PROVIDE DETAILS SIMILAR TO THOSE SHOWN.

- VERIFY ALL EXISTING CONDITIONS, DIMENSIONS, AND ELEVATIONS BEFORE STARTING WORK NOTIFY THE OWNER OF ANY DISCREPANCY.


11. THE CONTRACTOR IS SOLEY RESPONSBILE FOR THE DESIGN ADEQUACY, AND SAFETY OR ERECTION BRACKING, SHORING, TEMPROARY SUPPORTS, ETC. THE STRUCTURAL ELEMENTS ARE NOT TABLE UNTIL THE STRUCTURE IS COMPECTE.

- 12. REVIEW OF SHOP DRAWINGS OR OTHER SUBMITTALS BY THE OWNER DOES NOT RELIEVE THE CONTRACTOR OF RESPNBILSITY TO REVIEW AND CHECK SHOP DRAWINGS BEFORE SUBITTAL TO THE OWNER. THE CONTRACTOR REMAINS SOLEY RESPONSIBLE FOR ERRORS AND OMISSIONS ASSOCIATED WITH THE PREPERATION OF SHOP DRAWINGS AS THEY PERTAIN TO MEMBER SIZES. DETAILS, AND DIMENSION SPECIFIED IN THE CONTRACTOR DOCUMENTS.
- 13. THE CONTRACTOR IS SOLEY RESPONSBILE FOR THE MEANS, METHODS, TECHNIQUES, SEQUENCES, AND OPERATIONS OF CONSTRUCTION AND SAFETY PRECAUTIONS PROGRAMS INCOIENTAL THEREFO.
- 14. USE ONLY DIMENSIONS INDICATED ON THE DRAWINGS, DO NOT SCALE DRAWINGS OR USE ANY DIMENSIONS TAKEN FROM ELECTRONIC DRAWING FILES.
- 5. THE CONTRACTORS SHALL FURNISH ALL LABOR, MATERIALS, AND EQUIPMENT FOR SUCCESSFUL COMPLETION OF THE PROJECT.
- THE CONTRACTOR SHALL NOTIFY THE OWNER IMMEDIALTY OF ANY DISCREPANCIES BETWEEN THE PLANS AND ANY OTHER DOCUMENTS OR EXISTING CONDITIONS FOR RESOLUTION PRIOR TO PROCEEDING WITH THE WORK.
- 17. THE SPECIFICATIONS ARE AN INTERGRAL PART OF THE CONTRACT DOCUMENTS AND SHALL BE USED IN CONJUNCTION WITH THE DRAWNIGS. IN CASES, IF ANY, WHERE REQUIREMETINS INDICATED ON THE DRAWNIGS. DIFFER FROM THE SPECIFICATIONS, NOTIFY THE OWNER. FOR PRICING, ASSUME THE MORE STRIGNENT REQUIREMENT.
- 18. THE LOCATION OF ANY UTILITIES ON THE DRAWINGS ARE APPROXAMTE, MAY BE INCOMPLETE, AND THOSE SHOWN ARE NOT NECESSABILY ALL OF THE EXISTING UTILITES AND STRUCTURES. VERRICATION OF EXCAT LOCATIONS SHOULD BE MADE PRIOR TO ANY CONSTRUCTION.
- COMPACTION REQUIREMENTS: COMACTED TO 95% DENSITY IN ACCORDANCE WITH ASTM-d-1557.

- ALL CONCRETE WORK SHALL CONFORM TO ACI 301. "SPECIFICATION FOR STRUCTURAL CONCRETE FOR BUILDINGS. LATEST EDITION.
- UNLESS OTHERWISE NOTED ALL CONCRETE SHALL BE NORMAL WEIGHT AND HAVE THE FOLLOWING MINIMUM 28 DAY STRENGHTS:
- 3. FOUNDATION_ CONCRETE MIX DESIGNS SHALL BE SUBMITTED TO THE ENGINEER AND THE OWNER'S TESTING LAB FOR APPROVAL
- 5. RESPSONIBILITY FOR OBTAINING THE REQUIRED CONCRETE DESIGN STRENGTH IS THE RESPONIBILITY OF THE CONTRACTOR
- USE OF CALCIUM CHOLORIDE, CHORLIDE IONS, OR OTHER SALTS IN CONCRETE IS NOT PERMITTED. THE USE OF RECYLED CONCRETE IS NOT PERMITTED.
- 7. COLD JOINTS ARE NOT PERMITTED
- COAT ALL SABS WITH CURING COMPOUND WITHIN 24 HOURS OF PLACING. PRODUCT USED SHALL CONFORM WHITH ASTIM CADD AND SANLE COMPATIBLE WITH ADHERED FINISHES. A SISSIPATING FORMULATION SHALL BE USED AT CEMENTITOUS FINISHES.
- 9. THE CONTRACTOR SHALL COMPLETE THE FOUNDATION IS ONE POUR, EACH TRUCK WILL BE SAMPLED IN ACCORDANCE WITH ASTM C172, PERFORMTHE FOLLOWING TESTS IN ACCORDANCE WITH THE INDICATED STANDARD:
- SLUMP: ASTM C143
- 11. AIR CONTENT: ASTM C173
- 2. COMPRESSIVE STRENGTH: ASTM C39, WITH ONE CYLINDER AT 7 DAYS, 2 CYLINDERS AT 28 DAYS AND ONE SPECIMAN HELD IN RESERVE
- PROVIDE NORMAL WEIGHT CONCRETE WITH MINIMUM CURED DENSITY OF 145 PCF, AND AGGREGATE CONFORMING TO ASTM C33, UNLESS OTHERWISE NOTED.
- 14. CONCRETE SHALL ONLY BE POURED WHEN THE TEMPERATURE IS 40 F OR RISING.
- . CONCRETE PLACEMENT AT TEMPERATURES GREATER THAN 90 F SHALL BE DONE USING HOT WEATHER PLACEMENT AS PER ACI.

1. PROVIDE CONITNUOUS REINFORCEMENT WHERE EVER POSSIBLE: SPLICE ONLY AS SHOWN OR APPROVED: STAGGER SPLICES WHERE POSSIBLE: USE TENSION SPLICE (CLASS "9") UNIESS NOTED OTHERWISE. DOWELS SHALL MATCH THE SIZE AND SPACING OF THE SPECHFED REINFORCEMENT AND SHALL BE LAPPED WITH TENSION SPLICES (CLASS "8"). UNIESS OTHERWISE NOTE LAP LENGTHS EXPRESSED IN NUMBER OF BAR DIAMETERS SHALL BE AS EDITORIES.

#7 OR	#6 OR SMALLER		BAR SIZE
71 DIAM	57 DIAM	3,000	NORMA
62 DIAM	49 DIAM	4,000	NORMAL WEIGHT, F'C (PSI)
55 DIAM	44 DIAM	5,000	(PSI)
50 DIAM	40 DIAM	6,000	

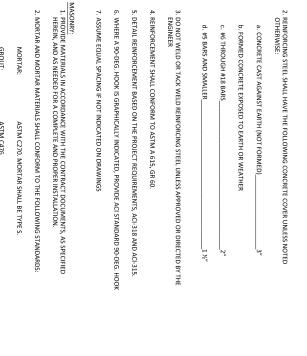

Drawing Title:

Savannah, Georgia

General Notes

Project Title:

Sylvan Terrace Neighborhood Sign

2. MORTAR AND MORTAR MATERIALS SHALL CONFORM TO THE FOLLOWING STANDARDS:

savannah

DEVELOPMENT SERVICES

EXTERIOR JT REINF: CONCRETE BLOCK: GROUT: JOINT REINF: REINFORCING BARS: MORTAR: ASTMA82, TRUSS OR LADDER TYPE GALVANIZE PER ASTM A153 ASTM A615, GRADE 60 ASTM C90, NORMAL WEIGHT - TYPE I ASTM C476

5515 Abercorn Street

912 - 351 - 3409 Savannah, GA 31405 CIP Management DEPARTMENT

INERIOR JT REINF: GALVANIZE PER ASTM A641

USE ONLY POTABLE WATER

DO NOT ADD ANTIFREEZE OR ACCERLERATING COMPOUNDS TO THE MORTAR.

CALCIUM CHLORIDE SHALL NOT BE USED IN MORTAR OR GROUT

- . ALL MASONRY WALLS SHALL HAVE HORZONITAL JOINT REINFORCEMNIT AT 16" OC MAXIMUM. HORIZONITAL JOINT REINFORCING AND ACCESSORIES SHALL BE TWO PIECE TYPE SIMILAR TO DUR-O-WALL 210/700. WIRE TO CONFORM TO ASTM ASZ. WIRE SHALL BE GALVINIZED CONFORMING TO ASTM 641 CLASS 1 (.04 OZ ZINC/S.F.)
- THE MINIMUM COMPRESSIVE STRENGTH OF THE MADORY (FM) SHALL BE 1.500 PS, UNLESS OTHERWISE NOTED. THE STRENGTH SHALL BE OBTAINED IN ACORDANCE WITH THE ABOVE REFERENCED SPECIFICATIONS FOR MASONRY STRUCTURES.
- ALL MASONRY UNITS SHALL BE PLACED WITH FULL FACESHELL MORTAR COVERAGE ON HORIZAONTAL AND VERTICAL FACE SHELLS. WEBBS SHALL ASLO HAVE FULL MORTAR COVERAGE FROUND ALL GROUTED CELLS.
- ALL CELLS WITH VERTICAL REINFORCING SHALL BE GROUTED SOLID.
- ". CMU BOND BEAMS WITH (2)-#5 CONT SHALL BE PLACED AT 4'-0 MAXIMUM CENTERS.
- 8. PROVIDE CONTROL JOINTS AT 20' O.C. MAX AND AT EACH SIDE OF EACH IN CMU WALLS. FILL JOINTS WITH WEATHERPROOF ELASTOMERIC SEALANT MEETING STANDARDS OF ASTM C320. 9. LAY MASONRY UNITS PLUMB AND NEAT TO LINE, WITH LEVEL HORIZONTAL JOINTS.
- 10. KEEP THE OPEN SPACE AT EXPANSION AND CONTROL JOINS FREE OF MORTAR BY USING CONTINUOUS WOOD OR METAL STRIP SET TEMPORARILY IN THE WALLS.
- 11. IF NECESSARY TO "STOP-OFF" A HO EACH COURSE. TOOTHING WILL NOT LOOSE UNITS AND CLEAN CONTACT DRIZONTAL RUN OF MASONRY, RACK BY HALF LENGTH IN TBE PERMITTED. WHEN WORK IS RESUMED, REMOVE SURFACES OF ALL MORTAR AND DEBRIS.
- DO NOT WET UNIT PRIOR TO SETTING. HOWEVER, IN DRYING WEATHER BRUSH, A SMALL AMOUNT OF WATER ON CONTACT SURFACES TO OBTAIN A GOOD BOND.


JSE OF THESE FILES AND DRAWINGS CONSTITUTES RECIPIENT'S AGREEMENT TO THE FOLLOWING:

IS MEDIA IS RESPRICTED TO THE REPARED METERAL SMALL NOT BE EXAMEDIATED TO METERAL SMALL NOT BE AMBIETABLE OF THE PROLIEGISTS. RELISE OF THE PROLIEGISTS. RELISE OF THE PROLIEGISTS. RELISE OF THE PROLIEGISTS. RELISE OF THE PROLIEGISTS. RELISES OF THE PROPERTY OF MICHIETABLE OF THE PROPERTY OF THE PROPER

DCG

- 13. LAY UNIT IN RUNNING BOND, UNLESS NOTED ELSE WHERE ON THE DRAWINGS.
- 14. LAY UNITS WITH FULL MORTAR COVERAGE ON HORIZONTAL AND VERTICAL FACE SHELLS. MAKE JOINTS UNIFORM. APPROXIMATELY 3/8" THICK.
- 15. WHEN FINISHED, WORK WILL BE I 5. WHEN FINISHED, WORK WILL BE EXPOSED TO VIEW, CUT JOINTS FLUSH AND TOOL WHEN "THUMB-PRINIT" HARD TO FORM A SLIGHLTY CONCAVE JOINT. WHEN TOOLING JOINTS, USE PRESSURE TO PRESS THE MORTAR AGAINST BOTH SIDES OF THE JOINT, CUT FLUSH ALL JOINTS WHICH WILL NOT BE EXPOSED TO VIEW, POINT UP ALL HOLES IN MORTAR, CUT OUT DEFECTIVE JOINTS AND REPOINT.
- 16. DO NOT LAY MASONRY WHEN TEMPERATURE OF AIR IS BELOW 40 DEGREES F, UNLESS SUITABLE MEANS, APPROVED BY THE OWNER ARE PROVIDED TO HEAT MATERIALS.
- IT. PROTECT FINISHED WORK FROM COLD AND FROST AND INSUEE THAT MORTAR WILL HARDEN WITH OUT FREEDING. DESIGN AND ERECT SCAFFOLDING SUFFICIENTLY AWAY FORM THE WALLS SO THAT MORTAR SPLATTER FROM DRIPPINGS WILL NOT AFFECT FACE OF WALL.
- 18. CLEAN EXPOSED MASONRY OF ALL SURFACE WITH A MASON'S BRUSH. . STAINS AND LOOSE MORTAR BY FREQUENTLY BRUSHING
- 19. DO NOT WET CONCRETE MASONRY UNTIL MORTAR HAS THOROUGHLY SET, CLEAN MASONRY IN ACCORDANCE WITH BRICK INSTITUTE OF AMERICA TECHNICAL NOTES #20 RECOMMENDATIONS AND IN ACCORDANCE WITH BRICK MANUFACTURE'S INSTRUCTIONS.

Architectural

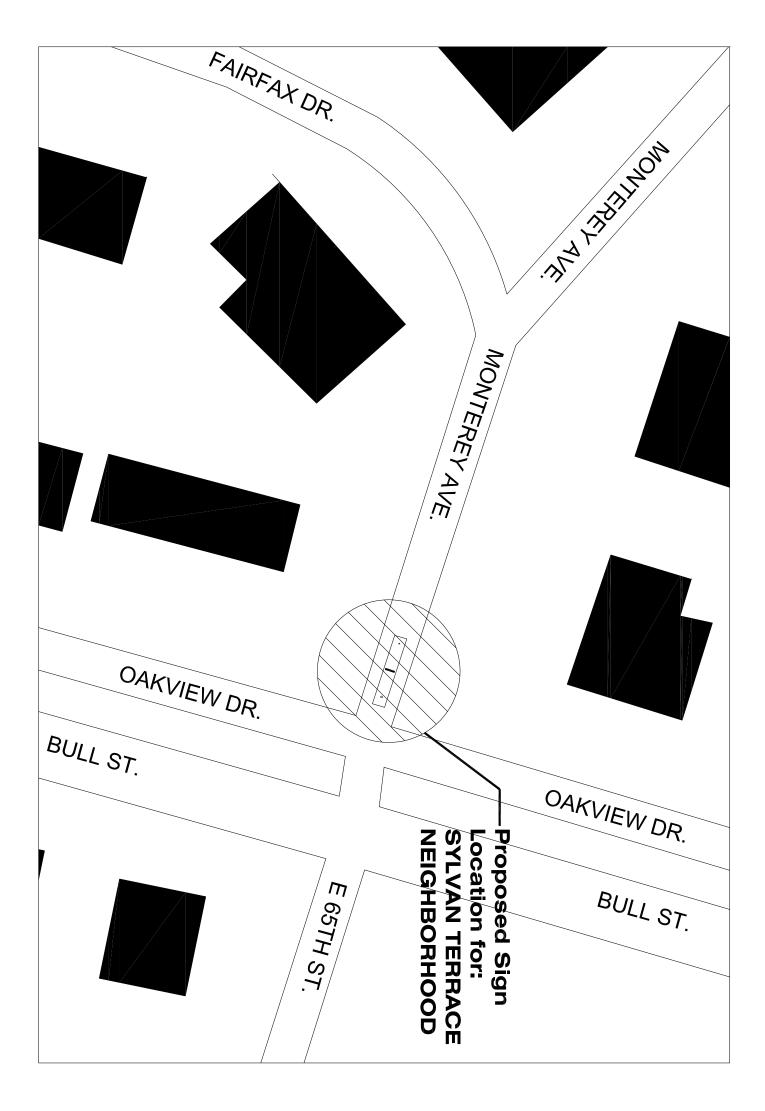

CIP Management 5515 Abercorn Street Savannah, GA 31405

912 - 351 - 3409


savannah

DEVELOPMENT SERVICES DEPARTMENT

Note: Contractor to locate sign at mid-point between ex xisting trees

Proposed Location

Scale: N.T.S.

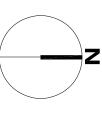

USE OF THESE FILES AND DRAWINGS CONSTITUTES RECIPIENT'S AGREEMENT TO THE FOLLOWING:


DCG

Architectural

SITE PLAN

Sylvan Terrace Neighborhood Sign

Project Title:

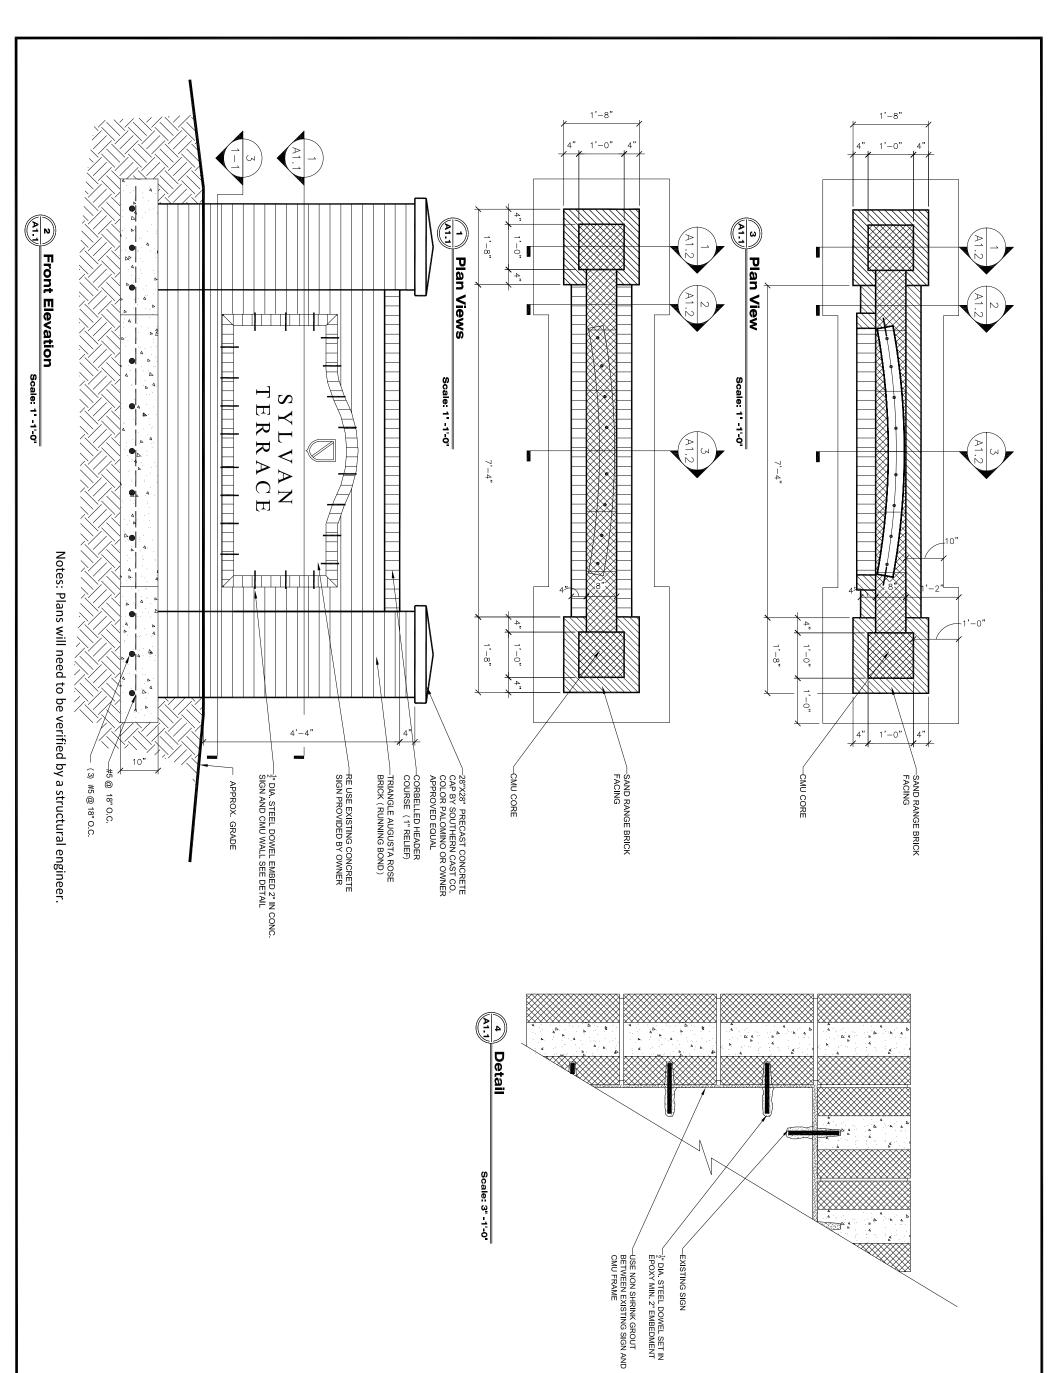

HIS MEDAN IS RESTRICTED TO THE OPPORTUNITE FOR WHICH IN WIS PROBLEMS TO BE RESTRICTED AND THE PROPERTY OF THE PROPERTY OF THE PROPERTY OF THE PROPERTY OF AREA OF REPRODUCTION OF THE DOLUMENTS OF HIGH TOP WHICH TOP WH

DCG

Architectural

USE OF THESE FILES AND DRAWINGS CONSTITUTES RECIPIENT'S AGREEMENT TO THE FOLLOWING:

Project Title:

Sylvan Terrace
Neighborhood Sign

savannah, Georgia

Drawing Title:

PLANS
&
ELEVATION

CIP Management 5515 Abercorn Street Savannah, GA 31405

912 - 351 - 3409

DEVELOPMENT SERVICES DEPARTMENT savannah

